

05-005-15

12.12.2016

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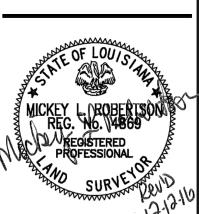
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othie Integration Group, L 8882 Florida Blvd. Walker, LA 70785 Contact: Roner Wilder III

Coursey Boulevard η Rouge, LA 70816

14110 Baton



EXISTING CONDITIONS MAP Sheet No.

HICKORY RIDGE, 4th FILING, PART 2

\_\_\_\_X \_\_\_\_X \_\_\_\_X \_\_\_\_X \_\_\_\_X \_\_\_\_X

ALL PAVEMENT, BASE, SUBGRADI & BACKFILL SECTIONS SHALL MEET THE REQUIREMENTS SET FORTH IN THE GEOTECHNICAL

KEY NOTES:

© CONCRETE SIDEWALK
SEE DETAIL 5, SHT C7

© CONCRETE DOOR LANDING SEE DETAIL 7, SHT C7

© CONCRETE CURB SEE DETAILS 1, SHT C7

FROM TODD SILVIO)

HANDICAP PARKING SYMBOL SEE DETAIL 13, SHT C7

CONCRETE BUMPER BLOCK SEE DETAIL 12, SHT C7

YELLOW (2 COATS)

O DROP INLET STORMWATER INSERTS SEE DETAIL 17, SHT C7

DROP INLET STORMWATER INSERTS
SEE DETAIL 18, SHT C7

N STRIPING

LEGEND:

K HANDICAP ACCESS UNLOADING ZONE SLOPE 2% MAX. EACH WAY (ADA

© DUMPSTER PAD TYP.SECTION SEE DETAIL 4 SHT C7

G CONCRETE DRIVE APRON
TO BE INSTALLED PER CITY/STATE DESIGN

STANDARDS PROVIDE CONCRETE PAVING

CONSTRUCTION AS SEE DETAILS 4 & 6,

HANDICAP PARKING SIGN (WALL MOUNTED)
SEE DETAIL 8, SHT C7

SHT C7 (CONTRACTOR TO OBTAIN PERMIT

COMPLIANT) AND STRIPE AS SHOWN, SEE DETAIL 7, SHT C7

MATCH EXISTING PER CITY AND OR STATE

STANDARDS. SEE DETAILS 6, SHT C7

PROPVIDE 4" WIDE PARKING LOT STRIPING AS SHOWN. USE HIGHWAY MARKING PAINT

PARKING SPACE COUNT

(SEE C-5 FOR DETAILS)

(SEE C-5 FOR DETAILS)

(SEE C-5 FOR DETAILS)

(SEE C-5 FOR DETAILS)

6" CONCRETE BARRIER CURB

REQ'D. DRAINAGE SERVITUDE

LIGHT DUTY P.C. CONCRETE PAVEMENT SECTION

HEAVY DUTY P.C. CONCRETE PAVEMENT SECTION


8" CONCRETE DUMPSTER PAD/DRIVEWAY APRON

STANDARDS (CPS 907-03). IF NO

A HEAVY DUTY CONCRETE PAVING SEE DETAIL 2, SHT C7

B LIGHT DUTY CONCRETE PAVING SEE DETAIL 3, SHT C7

REPORT.

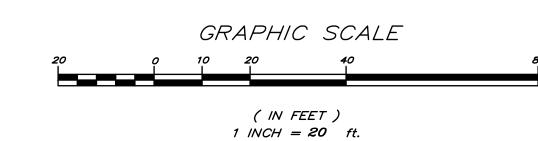

#### FLOOD NOTE:

THE SUBJECT PROPERTY AS SHOWN HEREON LIES WITHIN ZONE "X" AS SAID PROPERTY PLOTS BY SCALE ON THE FLOOD INSURANCE RATE MAP (FIRM) FOR EAST BATON ROUGE PARISH, STATE OF LOUISIANA, COMMUNITY-PANEL NUMBER 22033C0270E, DATED MAY 2, 2008. BASE FLOOD ELEVATION = 36'

## NOTES:

- 1. CONTRACTOR IS RESPONSIBLE TO MEET AND MATCH NEW PAVEMENT WITH EXISTING ADJACENT PAVEMENT AREAS. THE TRANSITION BETWEEN THIS SITE AND ADJACENT SITES MUST BE SMOOTH AND MONOLITHIC.
- 2. ALL DRIVEWAYS TO BE CONSTRUCTED IN ACCORDANCE WITH CPS 907-03 ATTACHED HERETO AND MADE A PART HEREOF.
- 3. CONTRACTOR SHALL REFER TO ARCHITECTURAL PLANS FOR PRECISE BUILDING DIMENSIONS, SERVICE AREA DIMENSIONS, AND ELEVATIONS. REFERENCE M.E.P. FOR EXACT BUILDING UTILITY ENTRANCE LOCATIONS.
- 4. ALL DIMENSIONS ARE MEASURED FROM EDGE OF PAVEMENT TO BUILDING, UNLESS OTHERWISE NOTED.
- 5. THE DISPOSAL OF DEMOLISHED ITEMS SHALL COMPLY TO ALL FEDERAL, STATE AND LOCAL REQUIREMENTS.
- 6. NO SERVITUDES EXIST PER THE REFERENCE MAP PROVIDED BY THE OWNER.

PARKING REQUIREMENTS:			
USE TYPE	REQ'D SPACES/UNIT	# OF UNITS	REQ'D SPACES
RETAIL	1 SP/300 SQ. FT	11,121	37
TOTAL SPACES REQ'D			37
TOTAL HC SPACES REQ'D			2
TOTAL BICYCLE SPACES REQ'D			1
TOTAL SPACES PROVIDED			59
TOTAL HC SPACES PROVIDED			3
TOTAL BICYCLE SPACES PROVIDED			1

NOTE: FOR PAVEMENT SECTIONS REFER TO DETAILS ON SHEET C-7

VERIFY ALL DIMENSIONS AND EXISTING CONDITIONS AT SITE

JULY 1, 2016 Checked By: 05-005-15 Project Number: Date:

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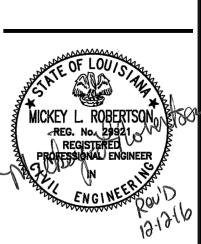
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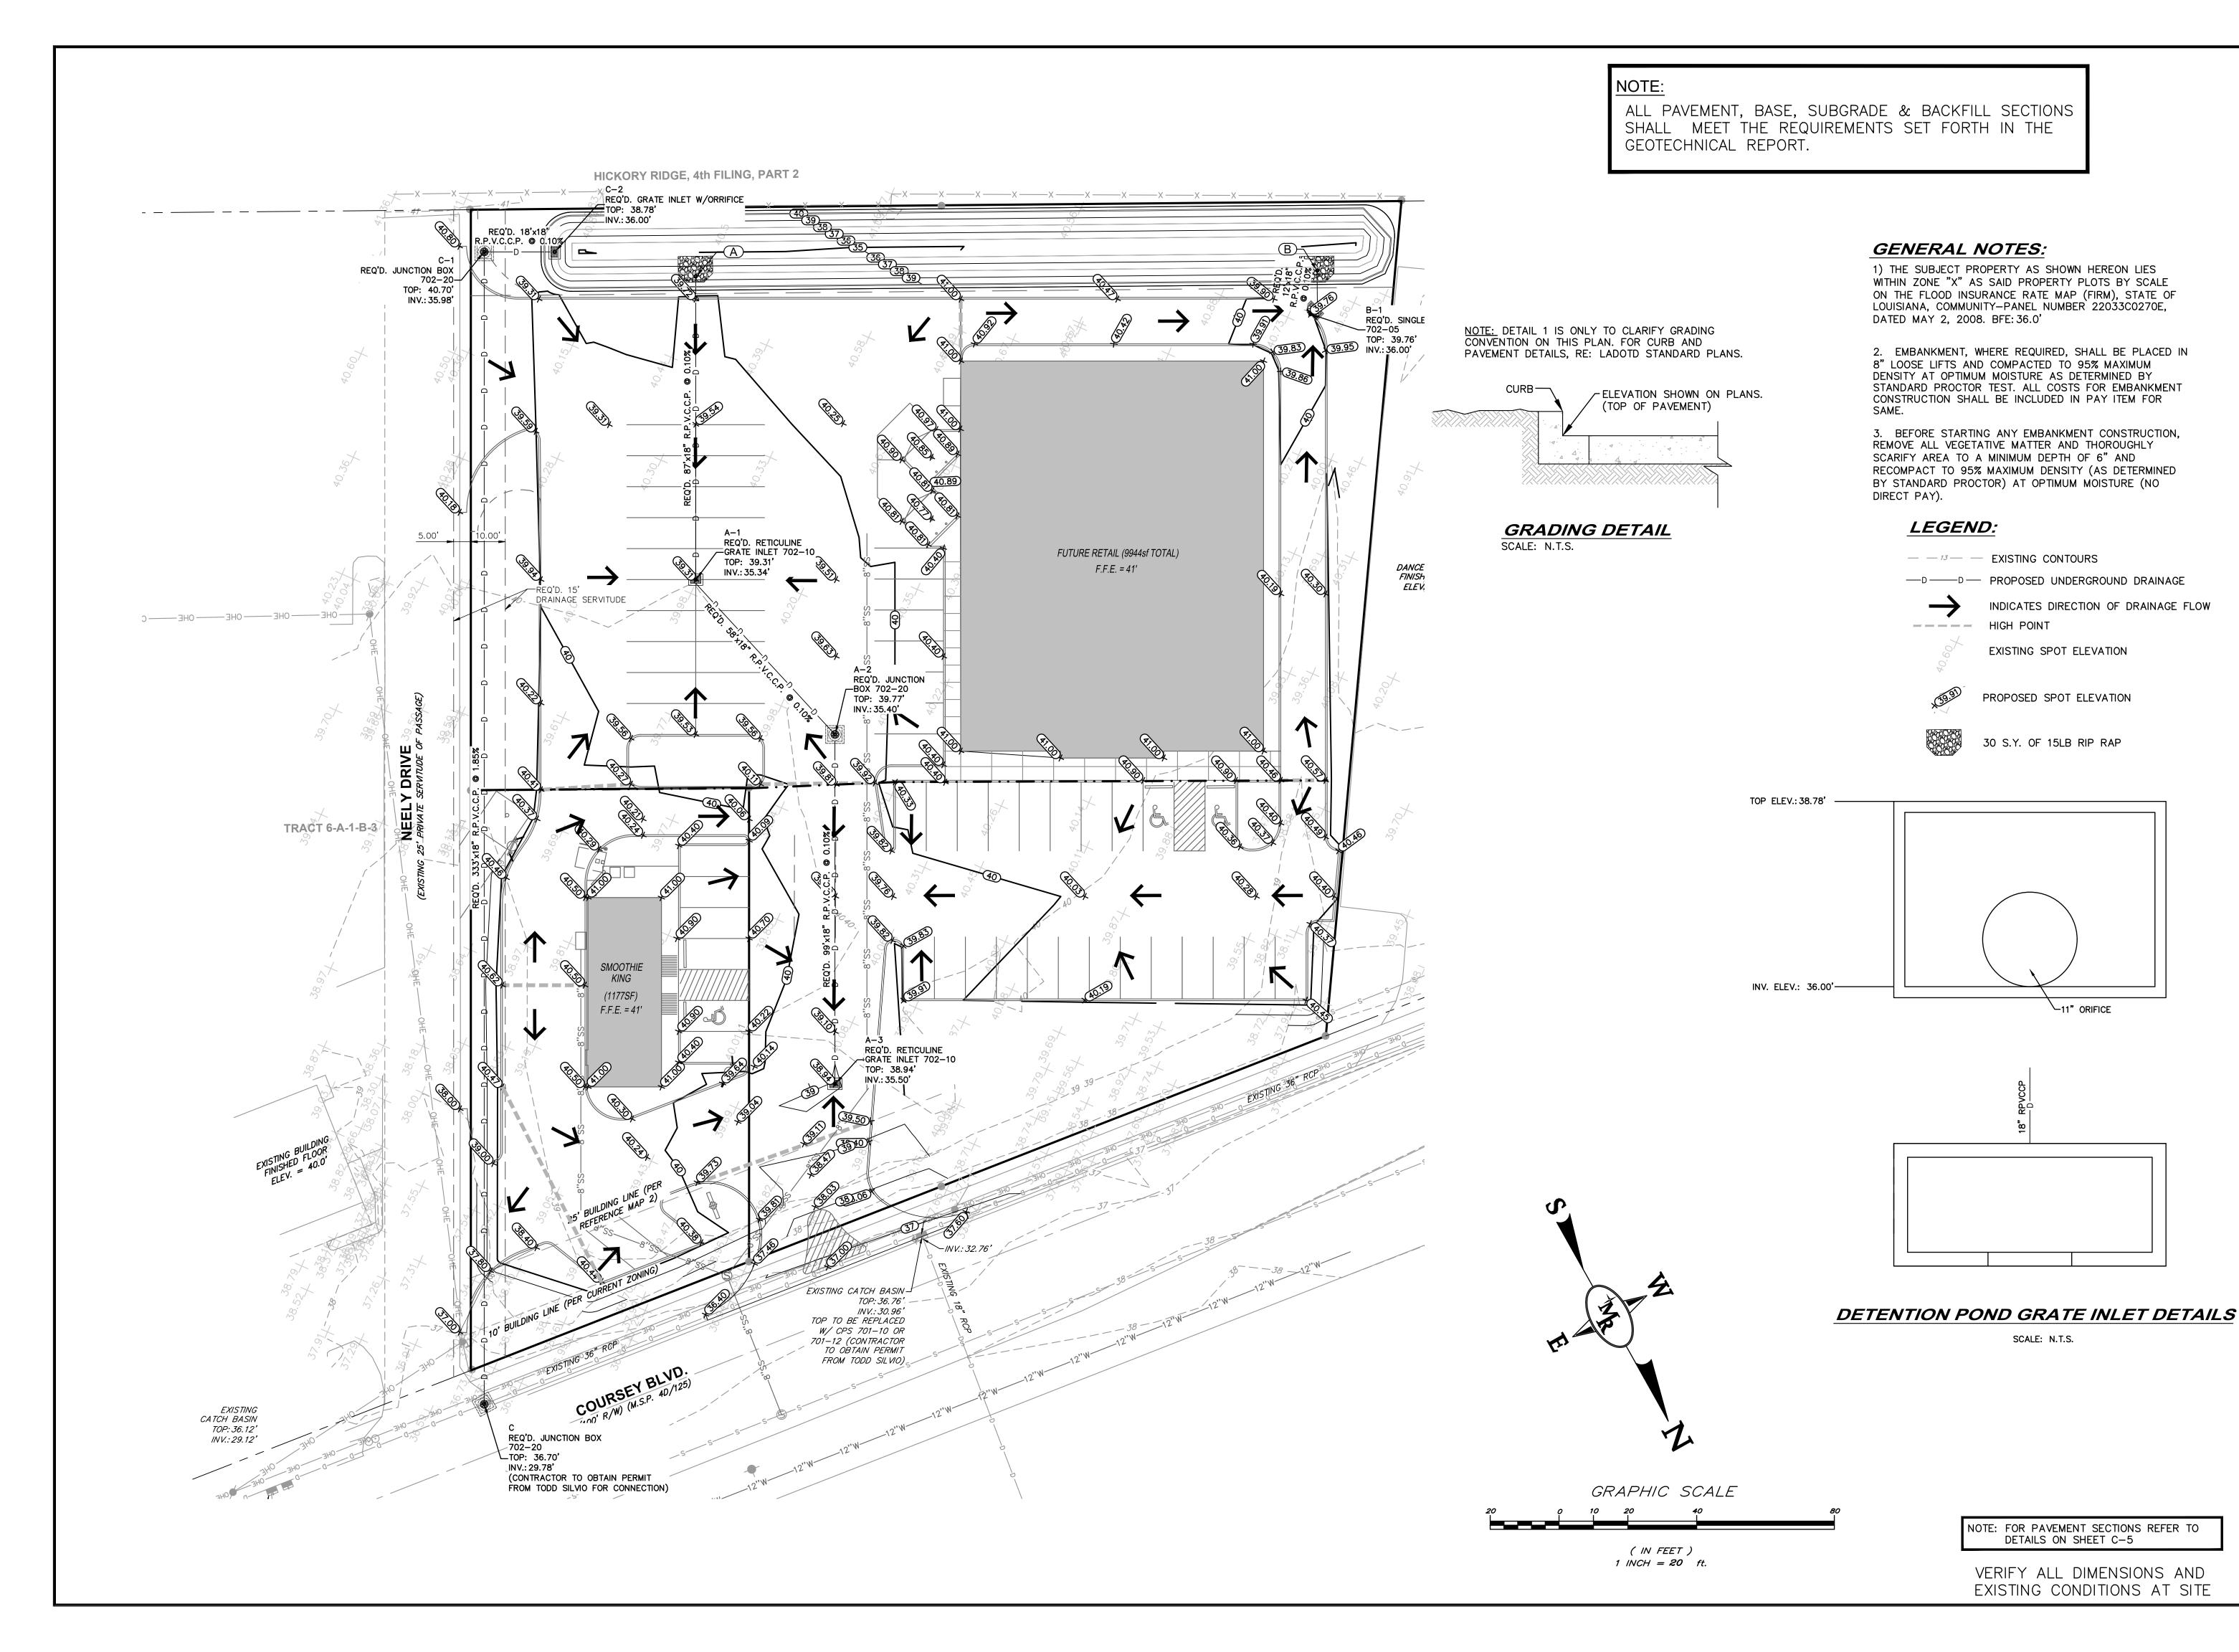
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SITE PLAN



JULY 1, 2016

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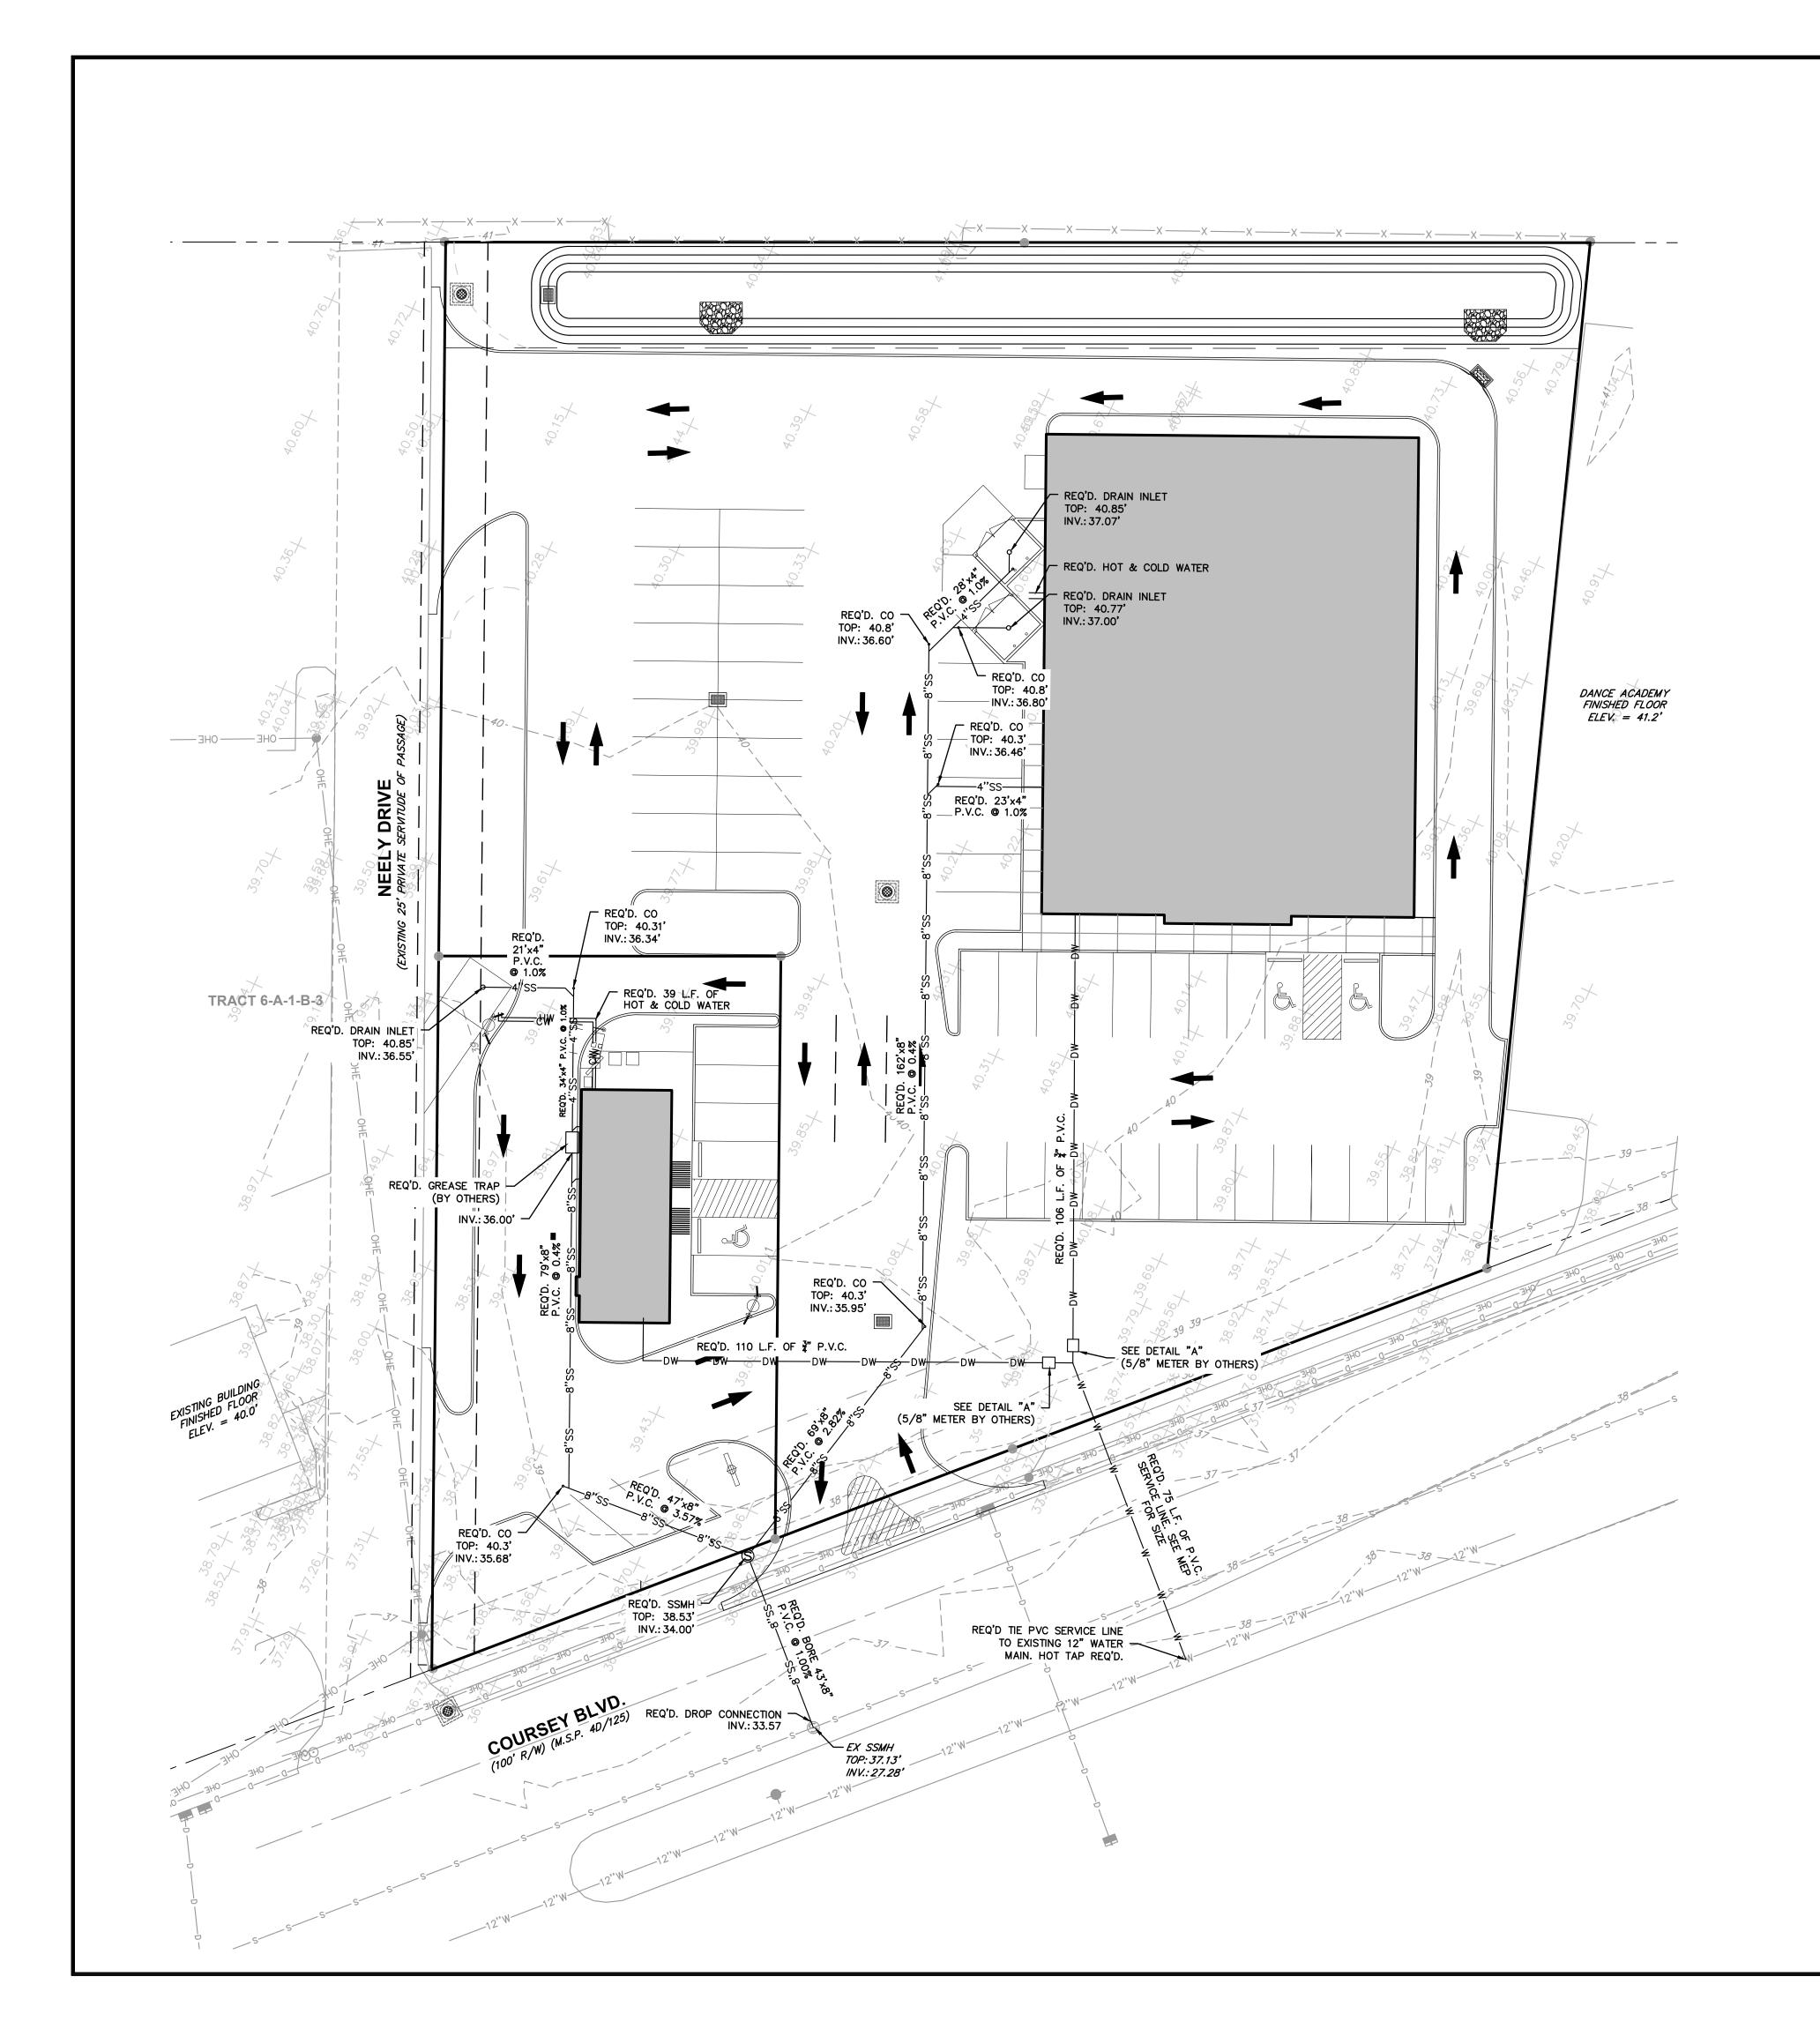
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GRADING & DRAINAGE LAYOUT Sheet No.



#### **GENERAL NOTES:**


1) THE CONTRACTOR SHALL VERIFY THE LOCATION OF ALL EXISTING UTILITIES WITH EAST BATON ROUGE AND LOUISIANA ONE CALL, PRIOR TO CONSTRUCTION AND THROUGHOUT CONSTRUCTION WHEN WORKING WITHIN CLOSE PROXIMITY OF EXISTING UTILITIES.

2) MINIMUM DEPTH OF CONNECTIONS AT THE PROPERTY LINE SHALL BE 4 TO 6 FEET BELOW THE NATURAL GROUND AT THE R/W LINE. CONNECTIONS FROM THE MAIN SEWER TO THE PROPERTY SHALL HAVE A MINIMUM SLOPE OF 1% AND 2% WHERE AVAILABLE DEPTH PERMITS.


3) ALL UTILITY TIE—INS SHALL BE COORDINATED WITH ASCENSION PARISH AND/OR THE UTILITY OWNER BEFORE THE CONNECTION IS MADE.

4) CONTRACTOR SHALL REFER TO ARCHITECTURAL PLANS FOR PRECISE BUILDING DIMENSIONS, SERVICE AREA DIMENSIONS, AND ELEVATIONS. REFERENCE M.E.P. FOR EXACT BUILDING UTILITY ENTRANCE LOCATIONS.


#### **EXISTING LEGEND**

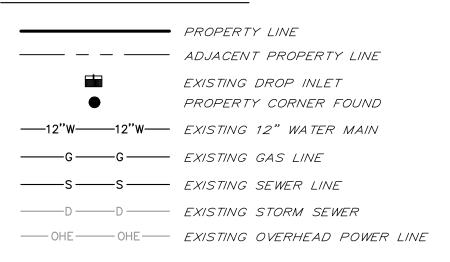

#### PROPOSED LEGEND

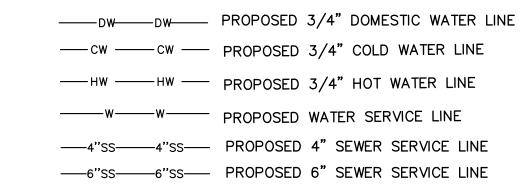

### DETAIL "A"

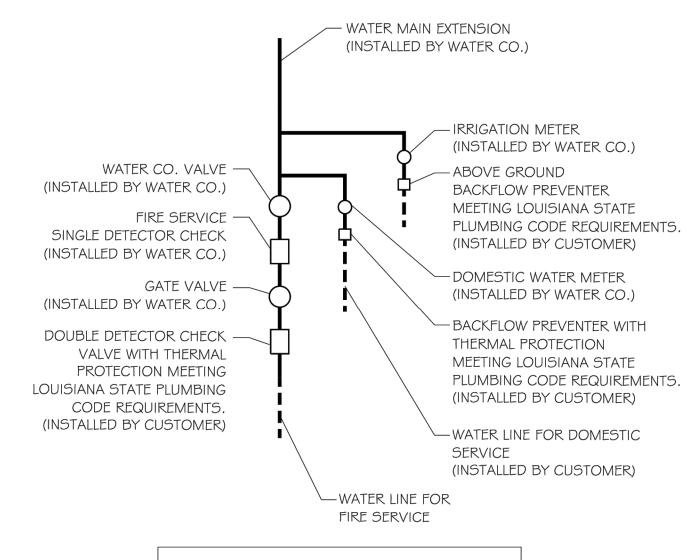

CONTRACTOR SHALL VERIFY METER, BFP, AND WATER LINE SIZES WITH ARCHITECTURAL PLANS.

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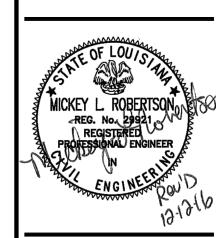
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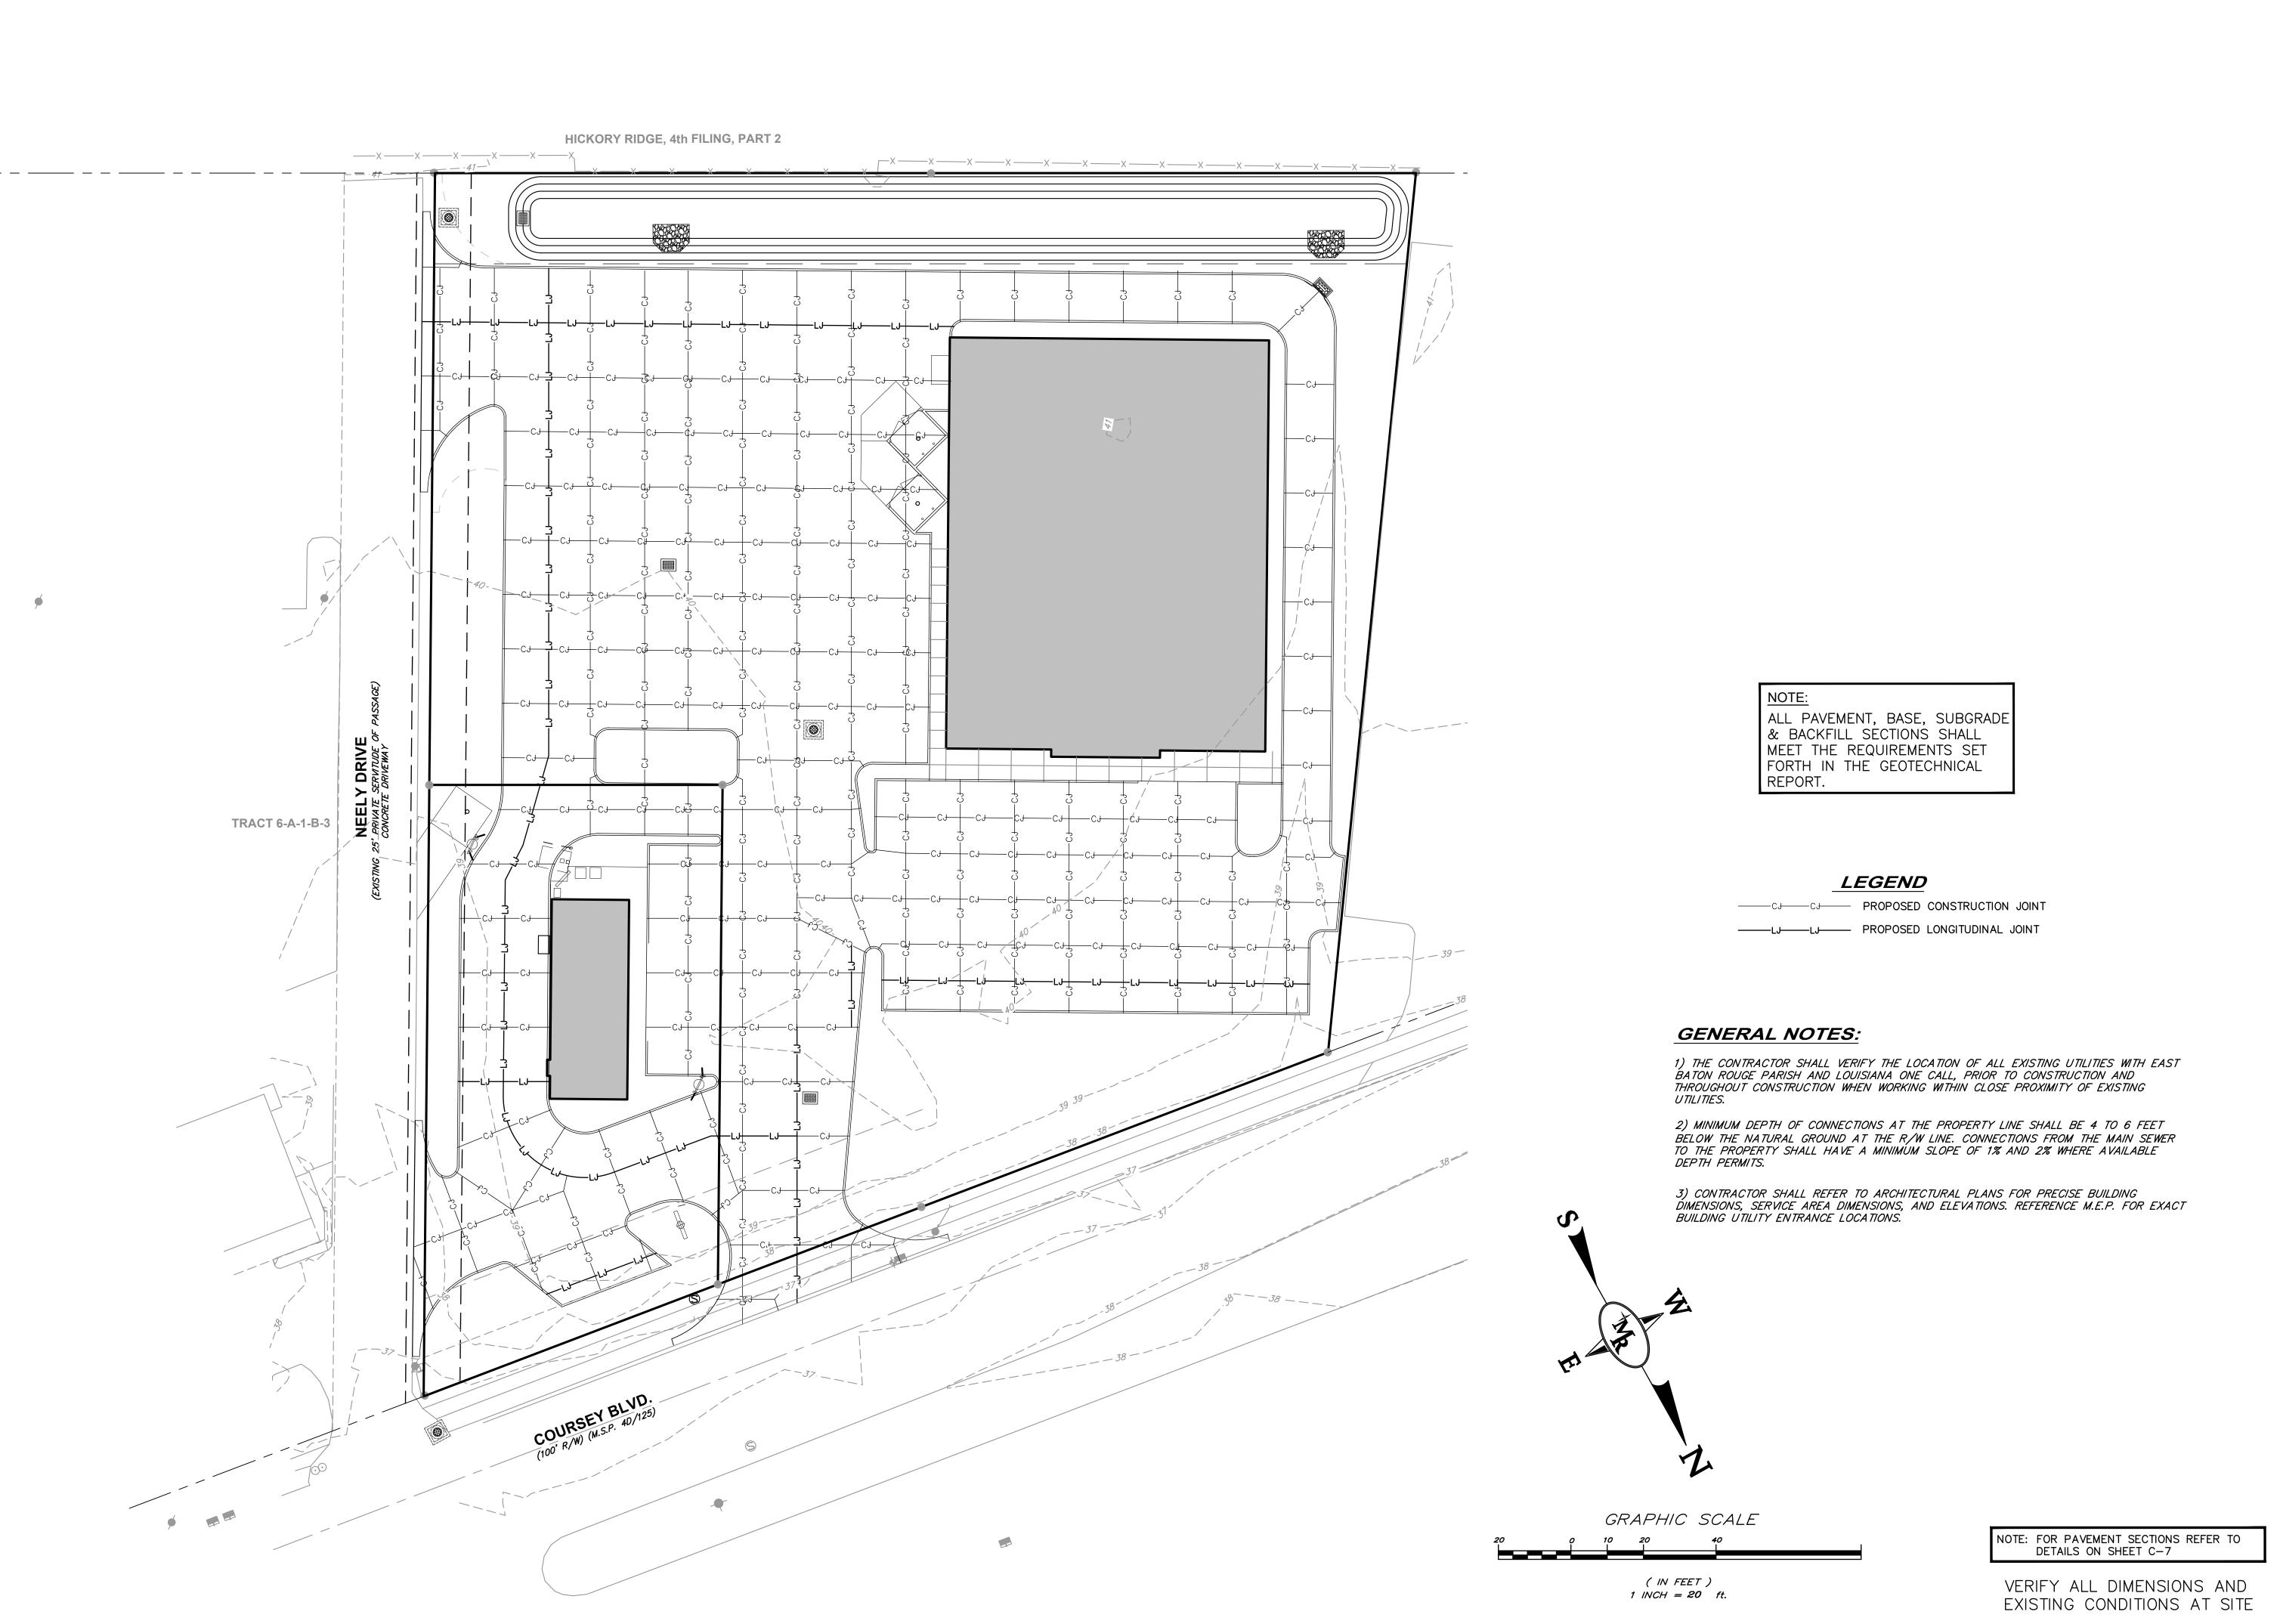
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UTILITY LAYOUT



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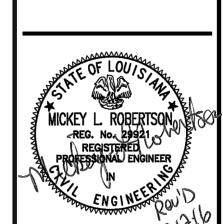
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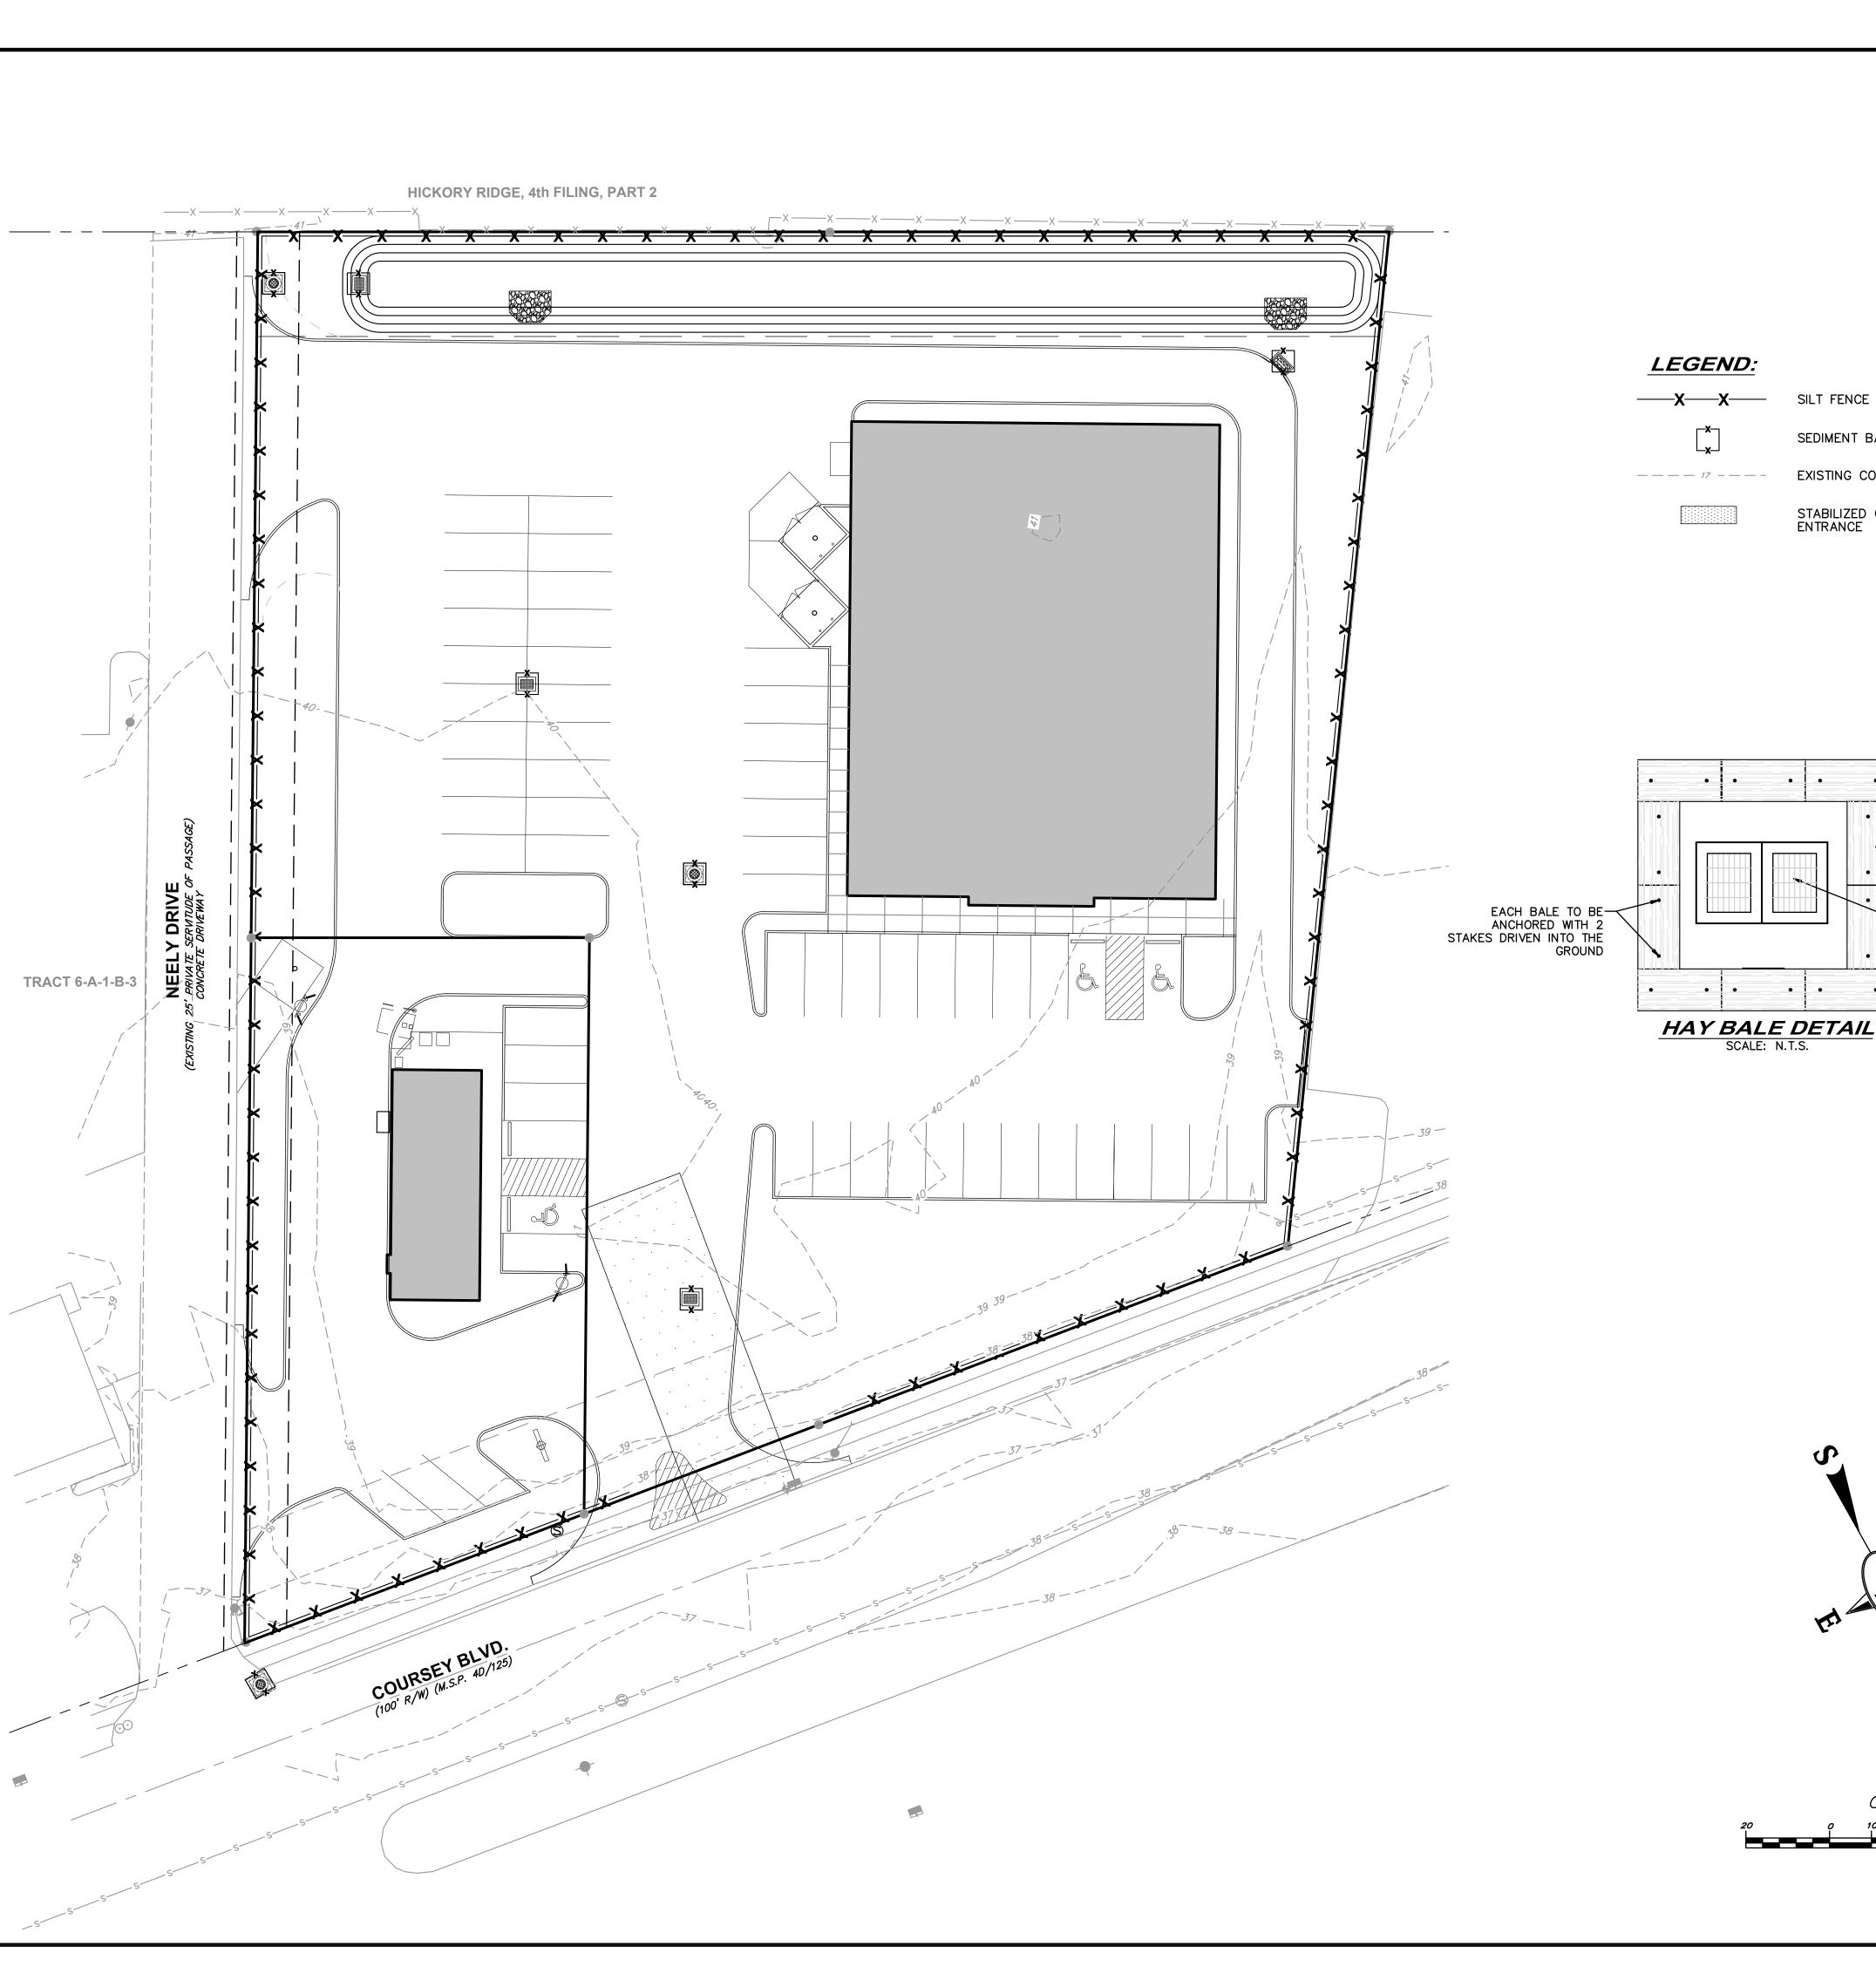
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Smoothie Integration Group, L 8882 Florida Blvd. Walker, LA 70785

oothie King #714 -Coursey



JOINT LAYOUT




NOTE: TOPOGRAPHIC INFORMATION SHOWN HEREON IS BASED UPON A SURVEY PROVIDED BY CLIENT. MR ENGINEERING & SURVEYING, LLC ASSUMES NO RESPONSIBILITY FOR ACCURACY OR COMPLETENESS.

EXTEND FABRIC INTO THE TRENCH FILTER FABRIC (PER LADOTD SPECIFICATIONS) —


# CONSTRUCTION OF A SILT FENCE

SCALE: N.T.S.

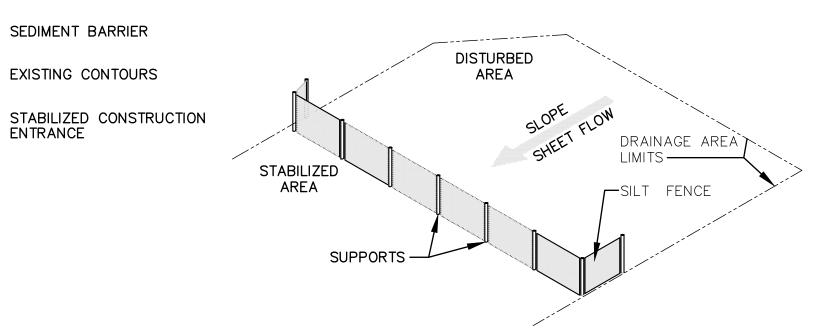

# DETAILS OF PLACING SILT FENCE

SCALE: N.T.S.

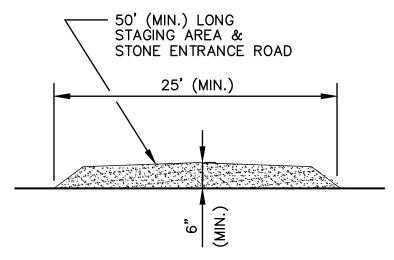

SECTION A-A SCALE: N.T.S.

## CERTIFICATION OF COMPLIANCE

WE, THE UNDERSIGNED CONTRACTOR(S), DO HEREBY AGREE TO THE EROSION AND SEDIMENTATION CONTROL PLAN AS OUTLINED BY THE SITE DEVELOPMENT FIRM AND AGREE TO MAINTAIN SUCH COMPLIANCE WITH THE EROSION AND SEDIMENTATION CONTROL PLAN ELEMENTS SHALL INCLUDE, BUT ARE NOT LIMITED TO;

NO LAND CLEARING OR GRADING SHALL BEGIN UNTIL ALL EROSION CONTROL MEASURES AND STRUCTURES HAVE BEEN INSTALLED AND/OR IN PLACE. ALL EXPOSED AREAS SHALL BE SEEDED AS SPECIFIED WITHIN 30 DAYS OF FINAL GRADING. MAINTAIN EROSION AND SEDIMENTATION CONTROL MEASURES/STRUCTURES AFTER EACH RAINFALL EVENT AND AT LEAST ONCE PER WEEK.

ALL NECESSARY MEASURES SHALL BE TAKEN TO THE EXTENT PRACTICABLE TO PREVENT SEDIMENT FROM LEAVING THE SITE(S).

ADDDITIONAL EROSION AND SEDIMENT CONTRAL MEASURES WILL BE PRACTICED IF DEEMED NECESSARY BY ON-SITE INSPECTIONS.

LAND DISTURBING ACTIVITIES SHALL NOT COMMENCE UNTIL APPROVAL HAS BEEN RECEIVED BY GOVERNING AUTHORITIES.

CONTRACTOR(S) AND SUB-CONTRACTOR(S) SHALL AGREE TO COMPLY WITH ALL STATE AND LOCAL ORDINANCES WHICH APPLY.

GENERAL CONTRACTOR

### **EROSION CONTROL NOTES:**

1. LAND DISTURBING ACTIVITIES SHALL NOT COMMENCE UNTIL APPROVAL TO DO SO HAS BEEN RECIEVED BY GOVERNING AUTHORITES. 2. NO LAND CLEARING OR GRADING SHALL BEGIN UNTIL ALL EROSION CONTROL MEASURES HAVE BEEN INSTALLED.

3. ALL EXPOSED AREAS SHALL BE SEEDED AS SPECIFIED WITHIN 30 DAYS OF FINAL GRADING. 4. SHOULD CONSTRUCTION STOP FOR LONGER THAN 15 DAYS, THE SITE SHALL


BE SEEDED AS SPECIFIED. 5. MAINTAIN EROSION CONTROL MEASURES AFTER EACH RAIN AND AT LEAST

6. THIS PLAN SHALL NOT BE CONSIDERED ALL INCLUSIVE AS THE CONTRACTOR SHALL TAKE ALL NECESSARY PRECAUTIONS TO PREVENT SOIL SEDMENT FROM LEAVING THE SITE.

7. CONTRACTOR SHALL COMPLY WITH ALL STATE AND LOCAL ORDINANCES 8. ADDITIONAL EROSION AND SEDIMENT CONTROL MEASURES WILL BE INSTALLED

IF DEEMED NECESSARY BY ON SITE INSPECTION. 9. COMPACT AND MAINTAIN 6" THICK STONE MATERIAL FOR CONSTRUCTION

10. CONTRACTOR SHALL BE RESPONSIBLE TO TAKE WHATEVER MEANS NECESSARY TO ESTABLISH PERMANENT SOIL STABILIZATION.

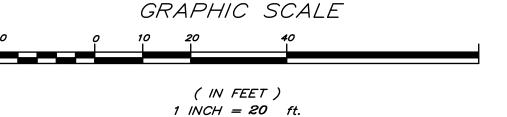

SILT FENCE

SEDIMENT BARRIER

EXISTING CONTOURS

— HAY BALES

PROTECTED

NOTE: FOR PAVEMENT SECTIONS REFER TO DETAILS ON SHEET C-7

VERIFY ALL DIMENSIONS AND EXISTING CONDITIONS AT SITE Project Number: 05-005-15

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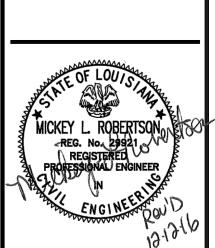
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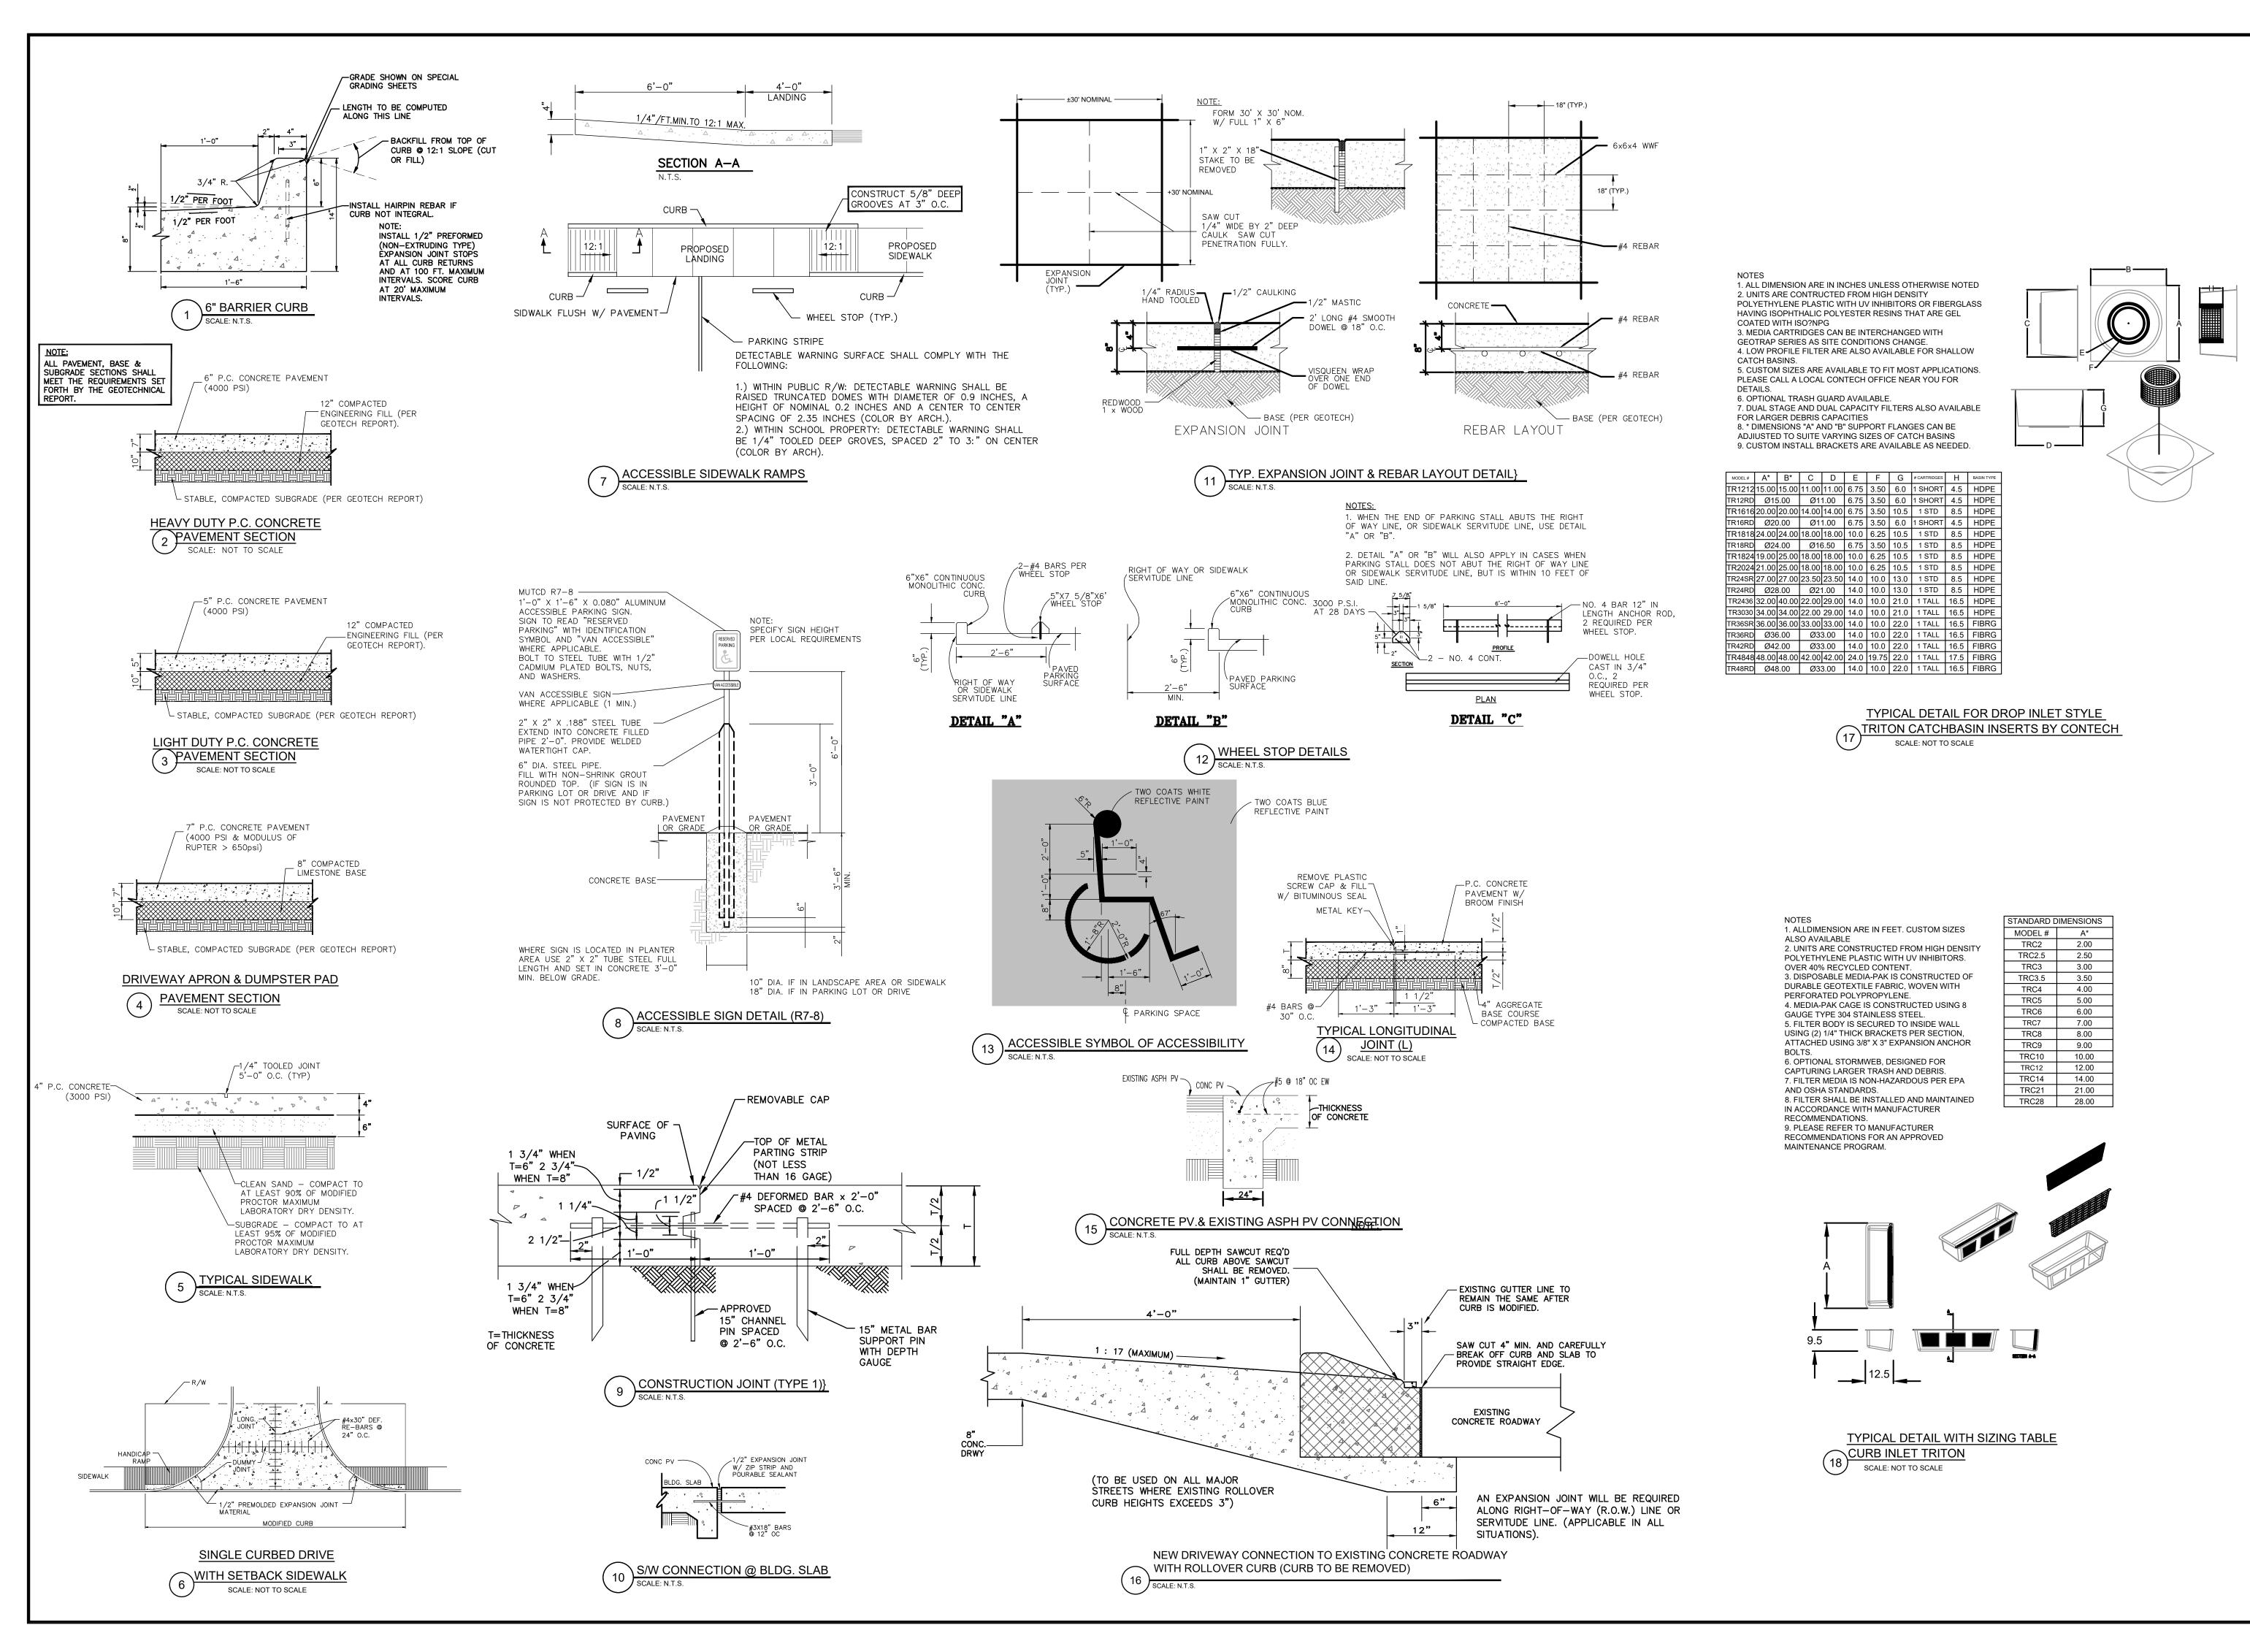
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EROSION CONTROL LAYOUT Sheet No.



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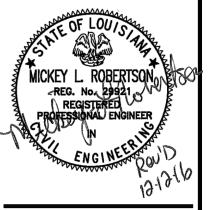
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ITE DETAILS